




	24x3				
	CHAS Constraints				
	PE SEAL:				
	ISSUED FOR BID				
	CLIENT INFO: TOWN OF OLD ORCHARD BEACH, ME OLD ORCHARD BEACH, ME VETERANS MEMORIAL PARK SITE IMPROVEMENTS				
	1 10/25/24 ADDENDUM 2 REV MM/DD/YY DESCRIPTION				
	DATE:OCTOBER 2024SCALE:AS NOTEDDESIGNED BY:EPDRAWN BY:JBCCHECKED BY:CSFILENAME:233371.11 C-30X.dwgDRAWING TITLE:				
	CIVIL GRADING & DRAINAGE PLAN - 1				
0 10' 20' BAR SCALE 1" = 10'	DRAWING NO: C-301				

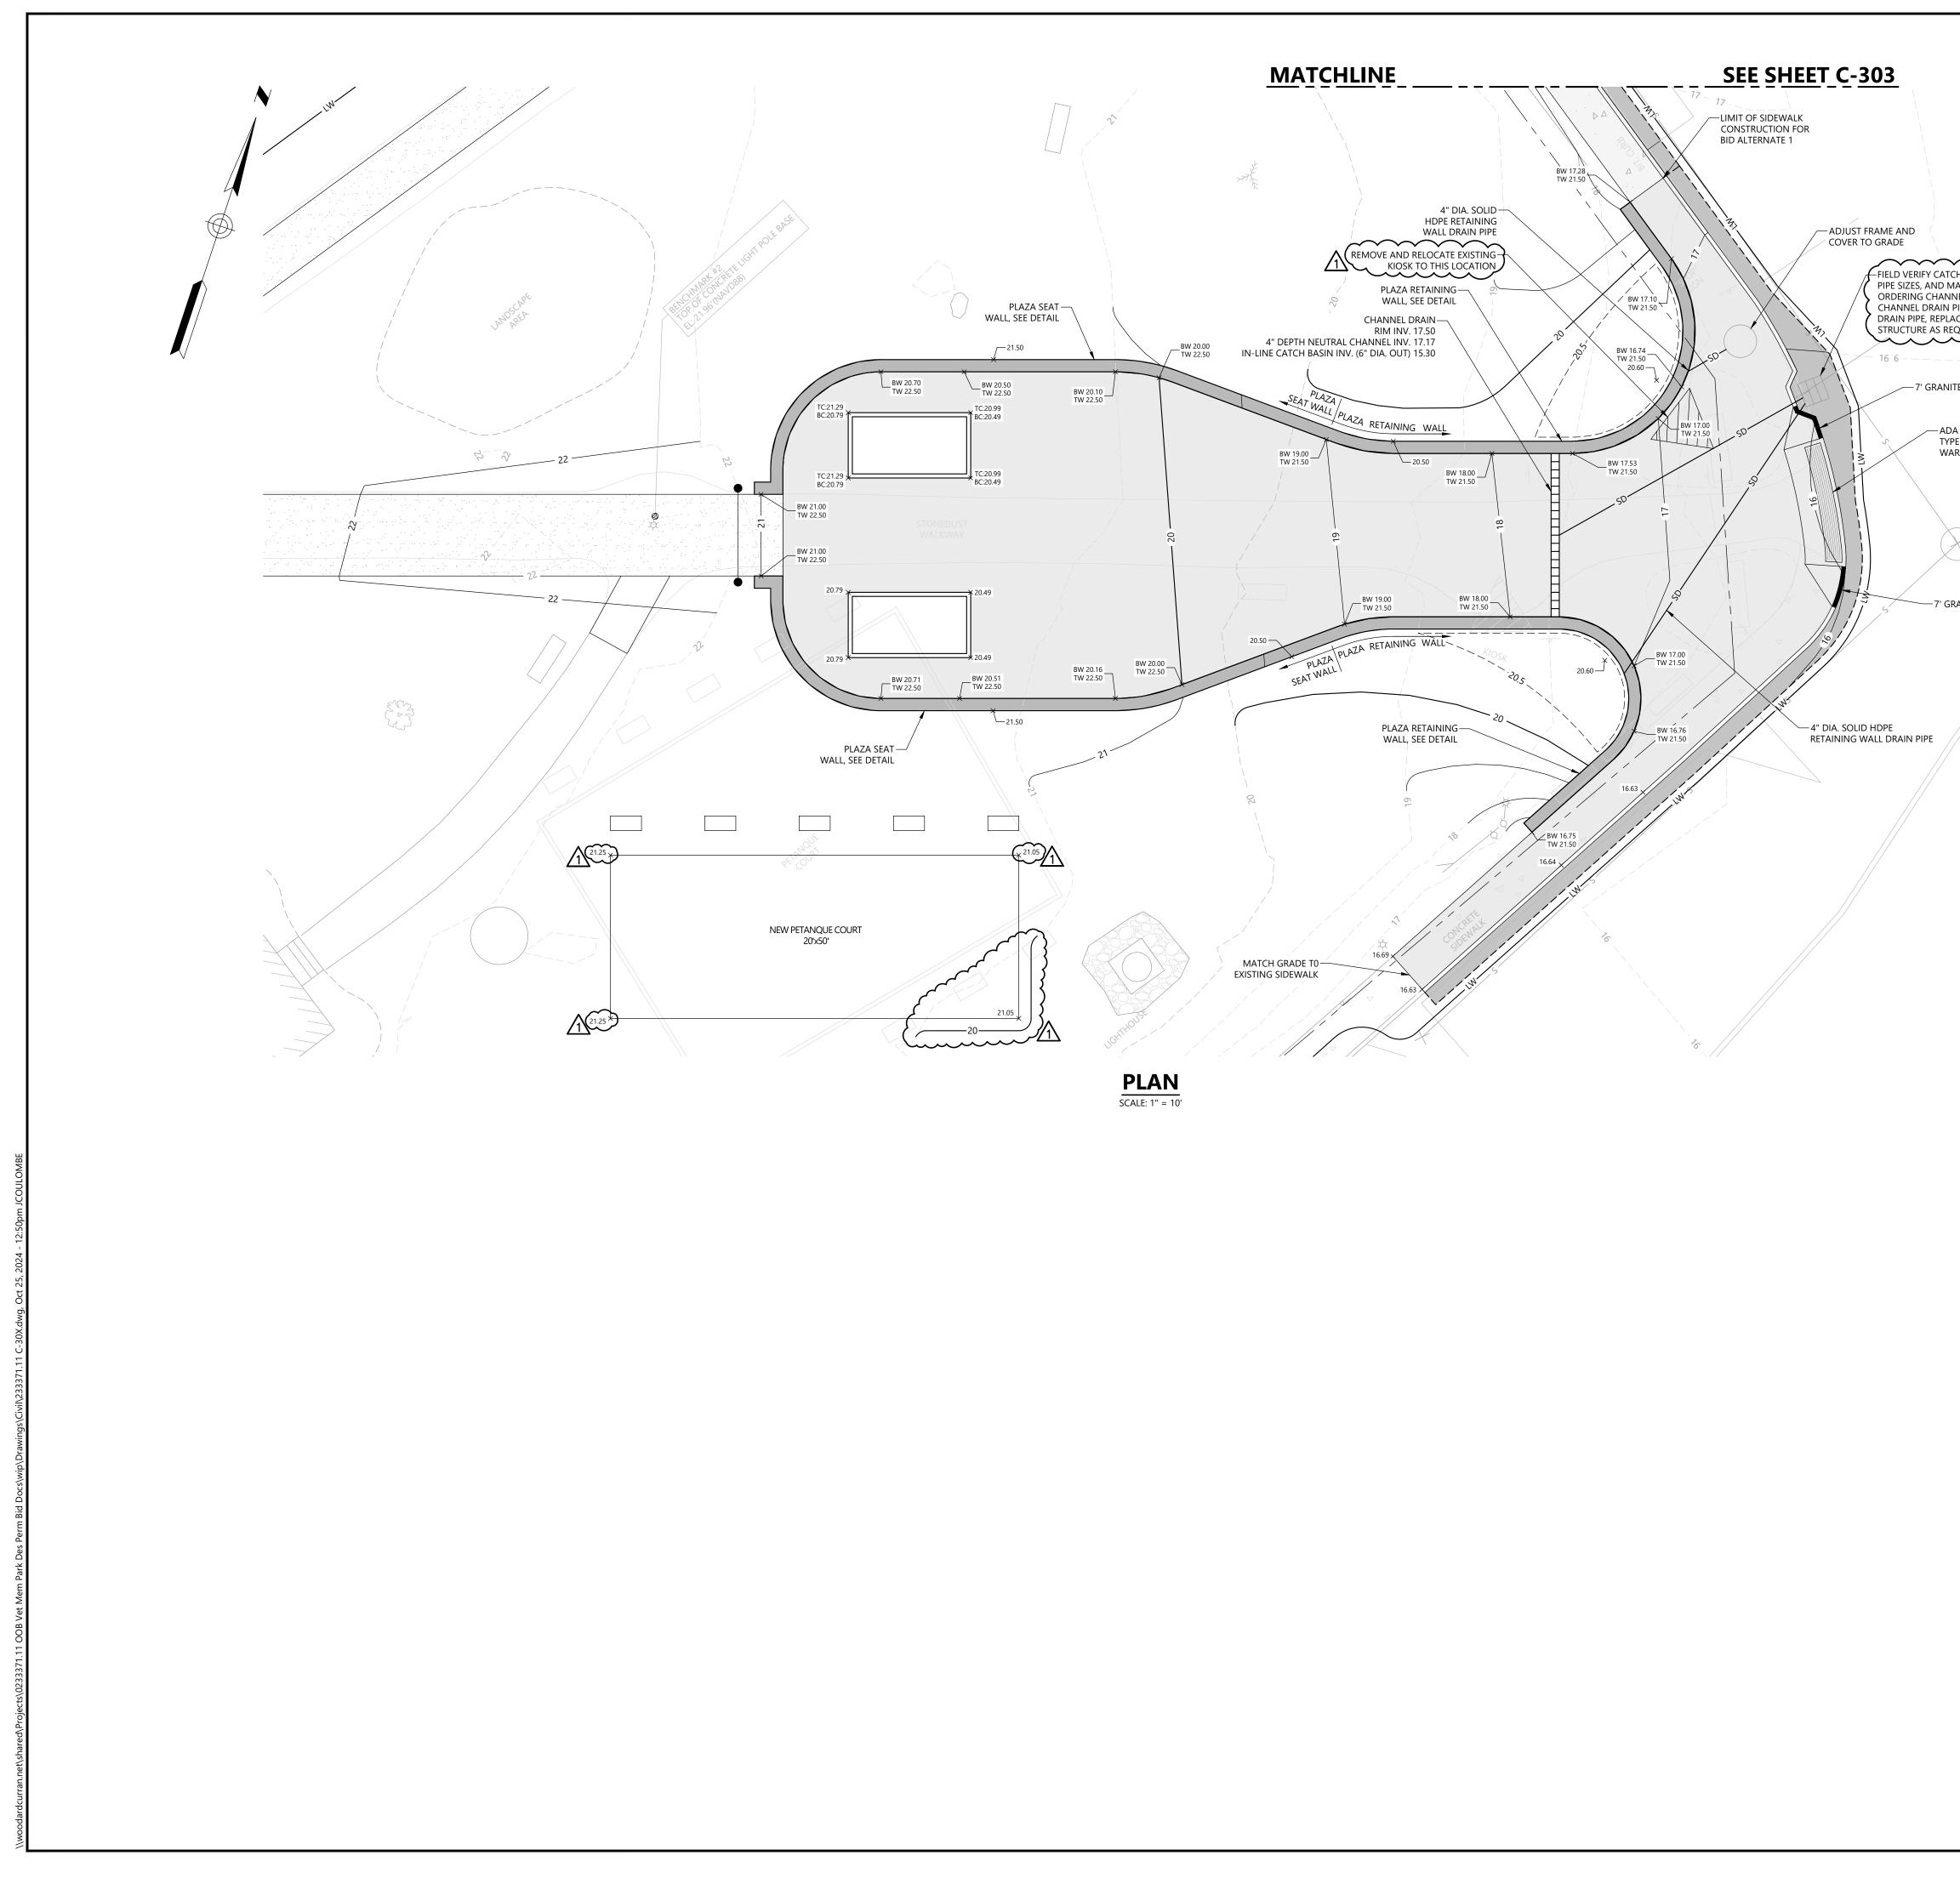

		24x3
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TH BASIN INVERTS, ATERIAL PRIOR TO VEL DRAIN, PIPE, AND WALL		
TE TIPDOWN		
A ACCESSIBLE CURB RAMP,		
E B W/DETECTABLE RNING SURFACE		
5		
ANITE TIPDOWN		
		PE SEAL:
		ISSUED FOR BID
		CLIENT INFO:
		TOWN OF OLD ORCHARD BEACH, ME OLD ORCHARD BEACH, ME
		VETERANS MEMORIAL PARK
		SITE IMPROVEMENTS
		110/25/24ADDENDUM 2REVMM/DD/YYDESCRIPTION
		JOB NO: 0233371.11 DATE: OCTOBER 2024
		SCALE: AS NOTED DESIGNED BY: EP DRAWN BY: JBC
		CHECKED BY: CS FILENAME: 233371.11 C-30X.dwg
		GRADING & DRAINAGE PLAN - 2
	10	
	10' 0 10' 20' BAR SCALE	DRAWING NO: C-302
	T" = 10 CHECK GRAPHIC SCALE BEFORE USING	

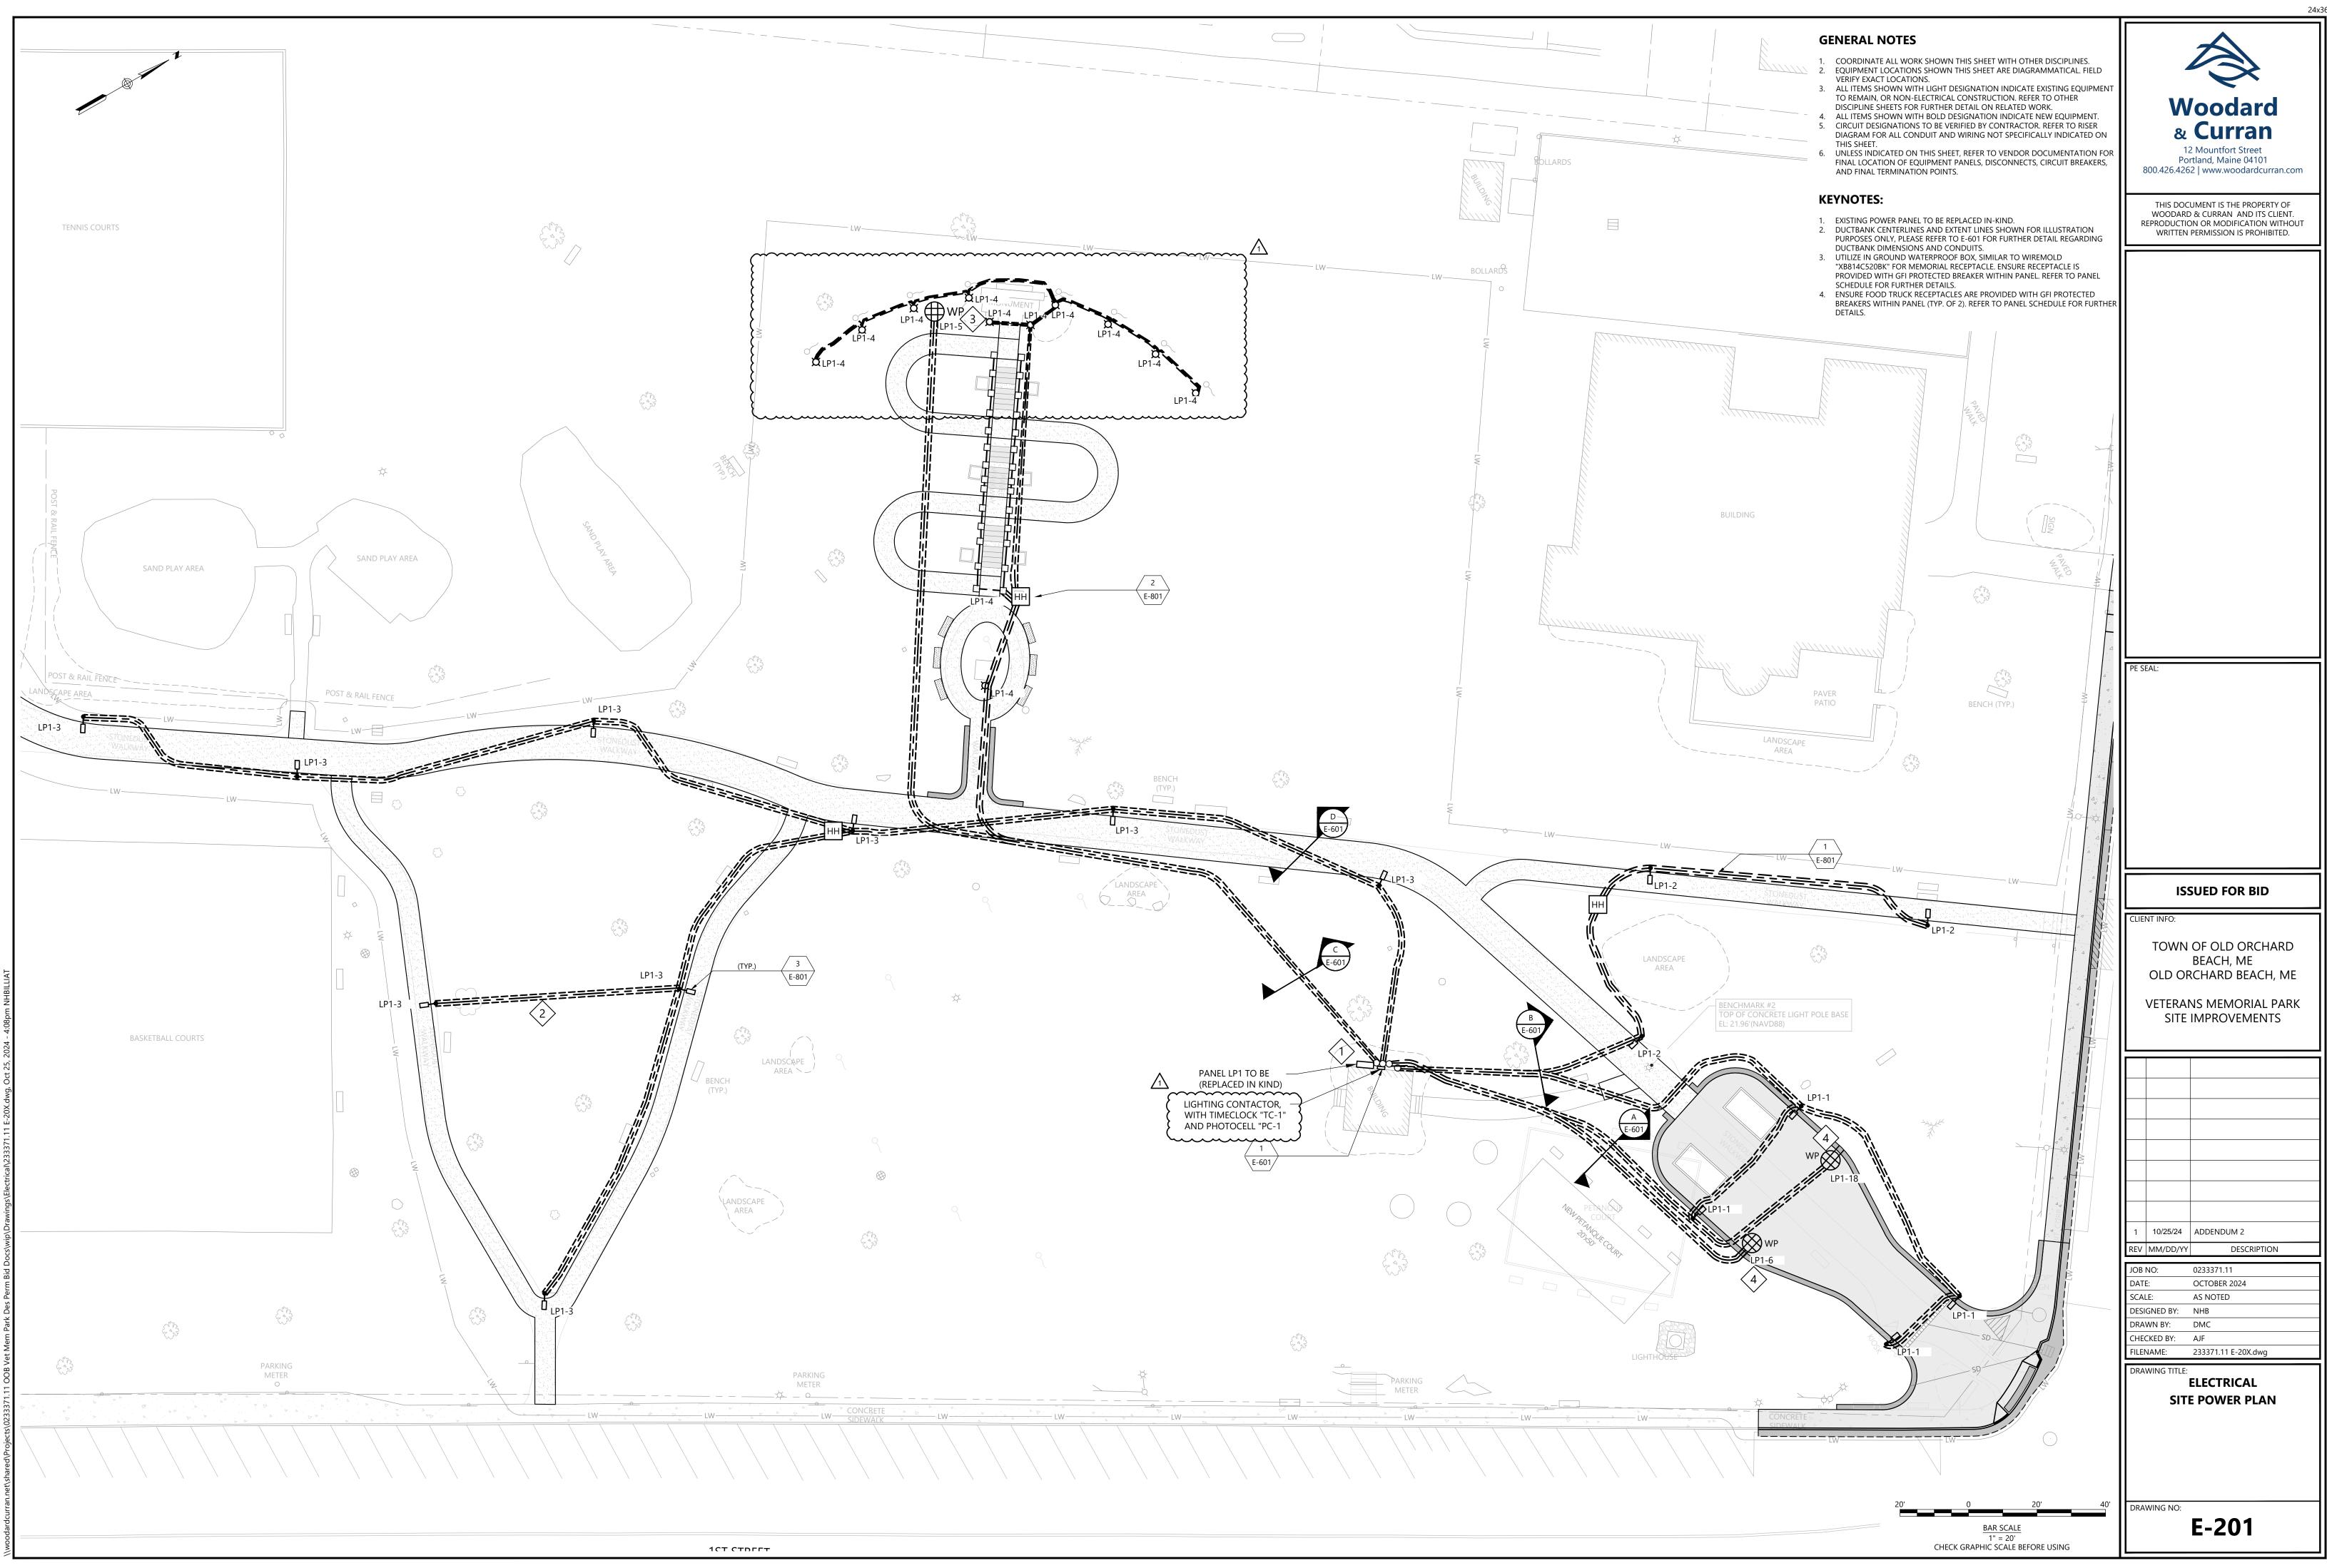

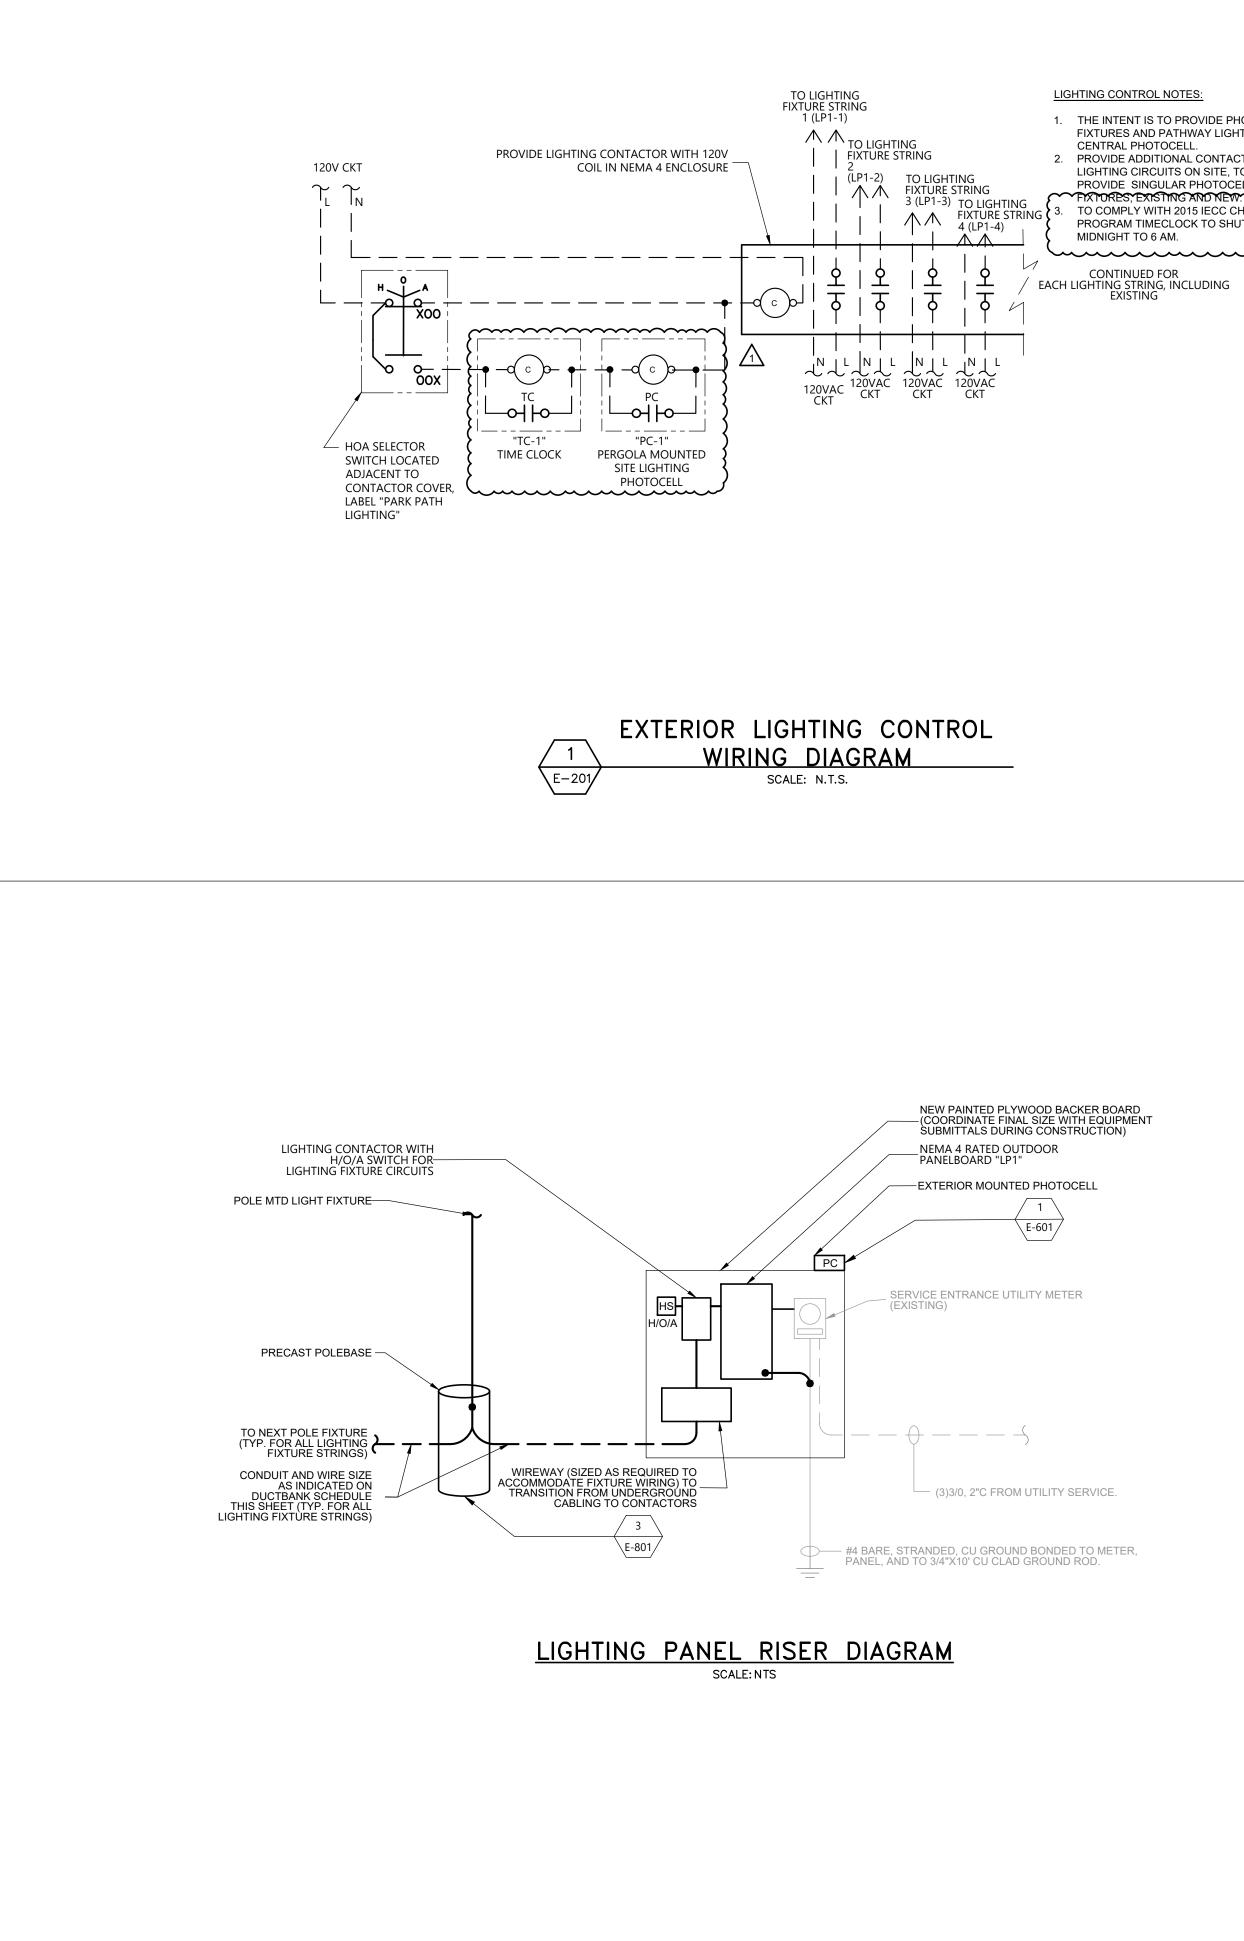

LIGHTING CONTROL NOTES:


- 1. THE INTENT IS TO PROVIDE PHOTOCONTROL TO ALL SITE FIXTURES AND PATHWAY LIGHTS THROUGH ONE CENTRAL PHOTOCELL. 2. PROVIDE ADDITIONAL CONTACTS FOR EXISTING
- LIGHTING CIRCUITS ON SITE, TO REMAIN. INTENT IS TO PROVIDE SINGULAR PHOTOCELL CONTROL TO ALL SITE
- TO COMPLY WITH 2015 IECC CHAPTER 4 05.2.5 PART 3, PROGRAM TIMECLOCK TO SHUT LIGHTS OFF FROM MIDNIGHT TO 6 AM. ······


					KVA LOADS								
DIRECTORY	BRKR	POLE	CKT#	KVA	Α	В	С	KVA	CKT#	POLE	BRKR	DIRECTORY	
SITE LIGHTING SOUTH	20	1	1	0.19	0.34			0.14	2	1	20	SITE LIGHTING EAST	
SITE LIGHTING WEST	20	1	3	0.43		0.83		0.40	4	1	20	SITE LIGHTING NORTH	
MONUMENT DEDICATED RCPT	20	1	5	0.36			0.72	0.36	6	1	20	FOOD TRUCK RCPTS A	
GR - A	20	1	7	0.36	0.72			0.36	8	1	20	GFI - B	
GR - C	20	1	9	0.36		0.72		0.36	10	1	20	GFI - D	
GR - E	20	1	11	0.36			0.72	0.36	12	1	20	GFI - F	
GR - G	20	1	13	0.36	0.72			0.36	14	1	20	GFI - H	
LIGHTS	20	1	15	1.00		2.00		1.00	16	1	20	X-MAS	
SPARE	20	1	17				0.36	0.36	18	1	20	FOOD TRUCK RCPTS B	
SPARE	20	1	19		0.00				20	1	20	SPARE	
SPARE	20	1	21			0.00			22	1	20	SPARE	
SPARE	20	1	23				0.00		24	1	20	SPARE	
SPARE	20	1	25		0.00				26	1	20	SPARE	
SPARE	20	1	27			0.00			28	1	20	SPARE	
SPACE	20	1	29				0.00		30	1	20	SPACE	
			SUBTOTAL			3.55	1.80	SUBTOTAL					
VOLTAGE:	120/208		т	OTAL kVA	A 7.13 PANEL NAME:		LP1						
MAIN BREAKER:	200		тот	AL AMPS	20			LOCATION:		N:	PERGOLA EXTERIOR		
BUSES:	200				· · ·			MOUNTING		IG:	SURFACE		
PH & WIRES:	1PH 3W		DDO ///57			0.01/45				AIC RATING: 22 kAIC		22 kAIC	

NOTES: PROVIDE INTEGRAL SURGE PROTECTIVE DEVICE. PROVIDE PROVISIONS FOR LOCKABLE COVER. PANEL SHALL BE NEMA 4X.

DOEL EL OWN TUDOU ON LO		LAMP TYPE	LAMP WATT	OUTPUT (LUWENS)	MOUNTING HEIGHT	T REMARKS/RECOMMENDATIONS	
DREL FLOW THROUGH IN-O	SRADE FIXTURE			, <u> </u>			
HYDREL OR EQUAL	M9700C-A-LED-P1-30K-MVOLT- NSP-FLC-LSF	LED	28.8	3424	GRADE	PROVIDE ALL FITTINGS, HUBS, AND ACCESSORIES TO MOUNT NEW FIXTURES	
IRFACE MOUNT STEP LIGH	TFIXTURE						
HYDREL OR EQUAL	HSL11-RECT-LED-30K-MVOLT	LED	2.95	39	1.5 FEET	PROVIDE ALL FITTINGS, HUBS, AND ACCESSORIES TO MOUNT NEW FIXTURES	
FT LED POST-TOP FULL C	UTOFF LANTERN FIXTURE				\sim	~~~~~~~~~~~~~~~~~~~~~~~~~~~~~~~~~~~~~~~	
HOLOPHANE OR EQUAL	PUCL3-P20-30K-MVOLT-FC2-	LED	48.16	5099 14 FFFT N		PROVIDE POLE WITH ALL REQUIRED ACCESSORIES FOR MOUNTING FIXTURE AND BASE, CONSISTENT	
				<u> </u>	└──── }	WITH POLE BASE DETAIL. POLE CAT NO: CLA-14-SL5-17D-C03-BK-GRD	
				ŢŢ	· · · · · · · · · · · · · · · · · · ·	PROVIDE POLE WITH ALL REQUIRED ACCESSORIES FOR MOUNTING FIXTURE AND BASE. CONSISTENT	
HOLOPHANE OR EQUAL	CLGL	LED	48.16	5701	14 FFFT (WITH POLE BASE DETAIL. POLE CAT NO: CLA-14-SL5-17D-C03-BK-GRD	
JR AF H(HYDREL OR EQUAL FACE MOUNT STEP LIGH HYDREL OR EQUAL T LED POST-TOP FULL C OLOPHANE OR EQUAL T LED POST-TOP FULL C	HYDREL OR EQUAL NSP-FLC-LSF RFACE MOUNT STEP LIGHT FIXTURE HYDREL OR EQUAL HSL11-RECT-LED-30K-MVOLT T LED POST-TOP FULL CUTOFF LANTERN FIXTURE OLOPHANE OR EQUAL PUCL3-P20-30K-MVOLT-FC2- CLGL T LED POST-TOP FULL CUTOFF LANTERN FIXTURE OLOPHANE OR EQUAL PUCL3-P20-30K-MVOLT-FC2- CLGL	HYDREL OR EQUAL NSP-FLC-LSF LED RFACE MOUNT STEP LIGHT FIXTURE HSL11-RECT-LED-30K-MVOLT LED HYDREL OR EQUAL HSL11-RECT-LED-30K-MVOLT LED T LED POST-TOP FULL CUTOFF LANTERN FIXTURE PUCL3-P20-30K-MVOLT-FC2- CLGL LED T LED POST-TOP FULL CUTOFF LANTERN FIXTURE PUCL3-P20-30K-MVOLT-FC2- CLGL LED OL OPHANE OR EQUAL PUCL3-P20-30K-MVOLT-FC5- LED LED	HYDREL OR EQUAL NSP-FLC-LSF LED 28.8 EFACE MOUNT STEP LIGHT FIXTURE ED 29.95 HYDREL OR EQUAL HSL11-RECT-LED-30K-MVOLT LED 2.95 T LED POST-TOP FULL CUTOFF LANTERN FIXTURE ED 48.16 OLOPHANE OR EQUAL PUCL3-P20-30K-MVOLT-FC2- CLGL LED 48.16 T LED POST-TOP FULL CUTOFF LANTERN FIXTURE ED 48.16	HYDREL OR EQUAL NSP-FLC-LSF LED 28.8 3424 EFACE MOUNT STEP LIGHT FIXTURE IGHT FIXTURE IED 2.95 39 HYDREL OR EQUAL HSL11-RECT-LED-30K-MVOLT LED 2.95 39 IT LED POST-TOP FULL CUTOFF LANTERN FIXTURE IED 48.16 5099 IT LED POST-TOP FULL CUTOFF LANTERN FIXTURE IED 48.16 5099 IT LED POST-TOP FULL CUTOFF LANTERN FIXTURE IED 48.16 5701	HYDREL OR EQUAL NSP-FLC-LSF LED 28.8 3424 GRADE RFACE MOUNT STEP LIGHT FIXTURE HSL11-RECT-LED-30K-MVOLT LED 2.95 39 1.5 FEET HYDREL OR EQUAL HSL11-RECT-LED-30K-MVOLT LED 2.95 39 1.5 FEET TT LED POST-TOP FULL CUTOFF LANTERN FIXTURE IED 48.16 5099 14 FEET OLOPHANE OR EQUAL PUCL3-P20-30K-MVOLT-FC2- CLGL LED 48.16 5099 14 FEET OLOPHANE OR FOULAL PUCL3-P20-30K-MVOLT-FC5- LED 48.16 5701 14 FEET	

	DUCT BANK SCHEDULE								
SECTION ID	CONDUIT	<u>USE</u>	<u>SIZE</u>	WIRE SIZE	FROM	<u>T0</u>	DESCRIPTION	NOTES	
٨	A1	POWER	1-1/2"	(2)#4, #4 GND	LP1, CIRCUIT 6	FOOD TRUCK			
A	A2	POWER	1-1/2"	(2)#4, #4 GND	LP1, CIRCUIT 18	FOOD TRUCK			
В	B1	POWER	1-1/2"	(2)#8, #8 GND	LP1, CIRCUIT 1	SITE LIGHTING SOUTH			
В	B2	POWER	1-1/2"	(2)#8, #8 GND	LP1, CIRCUIT 2	SITE LIGHTING EAST			
С	C1	POWER	1-1/2"	(2)#4, #4 GND	LP1, CIRCUIT 4	SITE LIGHTING NORTH			
C	C2	POWER	1-1/2"	(2)#6, #6 GND	LP1, CIRCUIT 5	MONUMENT DEDICATED RCPT			
D	D1	POWER	1-1/2"	(2)#6, #6 GND	LP1, CIRCUIT 3	SITE LIGHTING WEST			

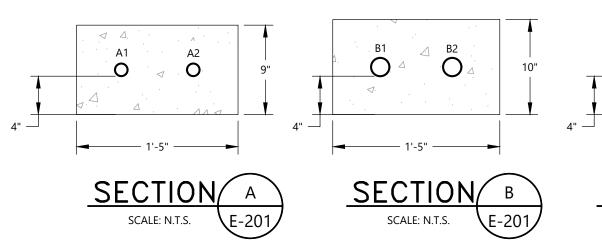

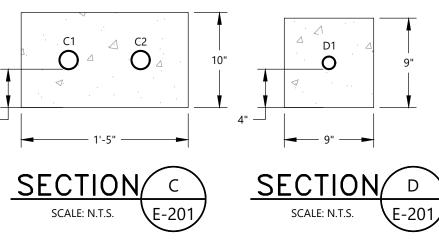

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BEACH, ME
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VETERANS MEMORIAL PARK SITE IMPROVEMENTS
1 10/25/24 ADDENDUM 2
REV MM/DD/YY DESCRIPTION
JOB NO: 0233371.11 DATE: OCTOBER 2024
SCALE: AS NOTED
DRAWN BY: DMC
CHECKED BY: AJF FILENAME: 233371.11 E-601.dwg
DRAWING TITLE: ELECTRICAL
WIRING DIAGRAMS AND
SCHEDULES
DRAWING NO
DRAWING NO: E-601